


FRONT ELEVATION


SCALE: 1/8" = 1'-0"

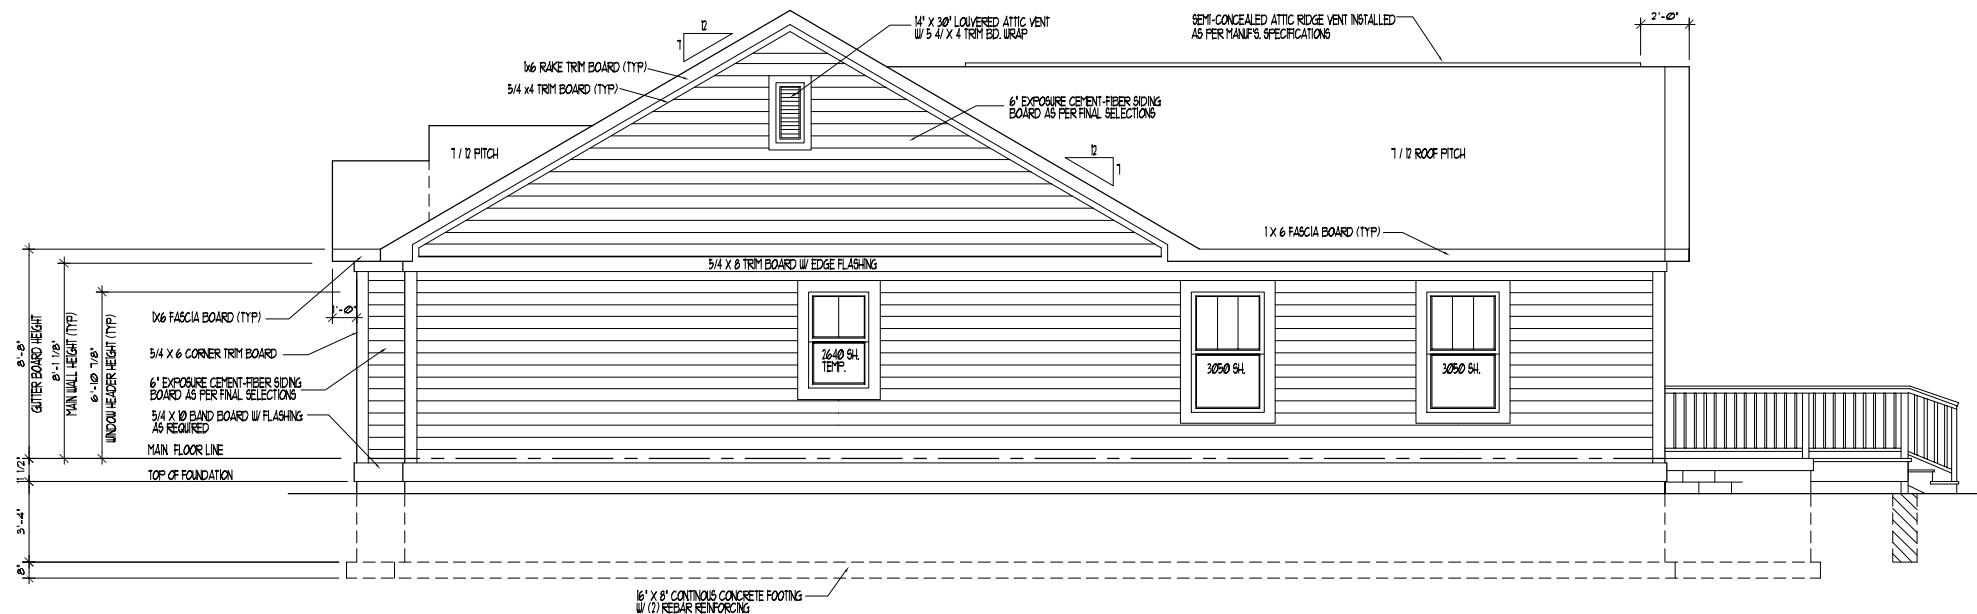

RIGHT SIDE ELEVATION

SCALE: 1/8" = 1'-0"

****NOTE****
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FORTE DESIGN

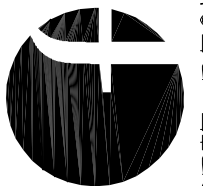CLIENT: RENEW INDIANAPOLIS
 1704 Bellefontaine St
 Indianapolis, IN 46202

LIVING S.F. 1237
 DRAWN BY M. Forte
 SCALE: 1/8"=1'-0"

DATE 6-16-22

WORK SITE: INDIANAPOLIS, INDIANA

SHT. NO. 1

OF 6


FORTE DESIGN INC
 RENEW INDIANAPOLIS

ROOF PLAN LAYOUT

APPLIES TO ROOF TRUSS FRAMING ONLY

- ALL TRUSS DESIGN CRITERIA SHALL BE SUBMITTED BY THE TRUSS MANUFACTURER SELECTED BY THE CONTRACTOR. THIS INFORMATION SHALL BE SIGNED AND SEALED BY A STRUCTURAL ENGINEER REGISTERED IN THE STATE OF INDIANA. TRUSSES ARE NOT TO BE MANUFACTURED UNTIL THIS INFORMATION HAS BEEN SUBMITTED AND APPROVED BY THE ARCHITECT.
- ROOF TRUSS LOADING CRITERIA:**

TOP CHORD LIVE LOAD	30 P.S.F.
TOP CHORD DEAD LOAD	10 P.S.F.
BOTTOM CHORD DEAD LOAD	10 P.S.F.
TOTAL LOAD	50 P.S.F.
- PROVIDE 2 X 4 "X" BRACING ACROSS TRUSSES AT EACH SIDE OF TRUSS ALTERNATE DIRECTION OF EACH SIDE.
- CUTTING AND NOTCHING OF STRUCTURAL WOOD MEMBERS SHALL BE ALLOWED ONLY AS ALLOWED IN THE INDIANA STATE BUILDING CODE.
- ALL MEMBERS CARRYING CONCENTRATED LOADS SHALL BE DESIGNED IN ACCORDANCE WITH THE INDIANA STATE BUILDING CODE.

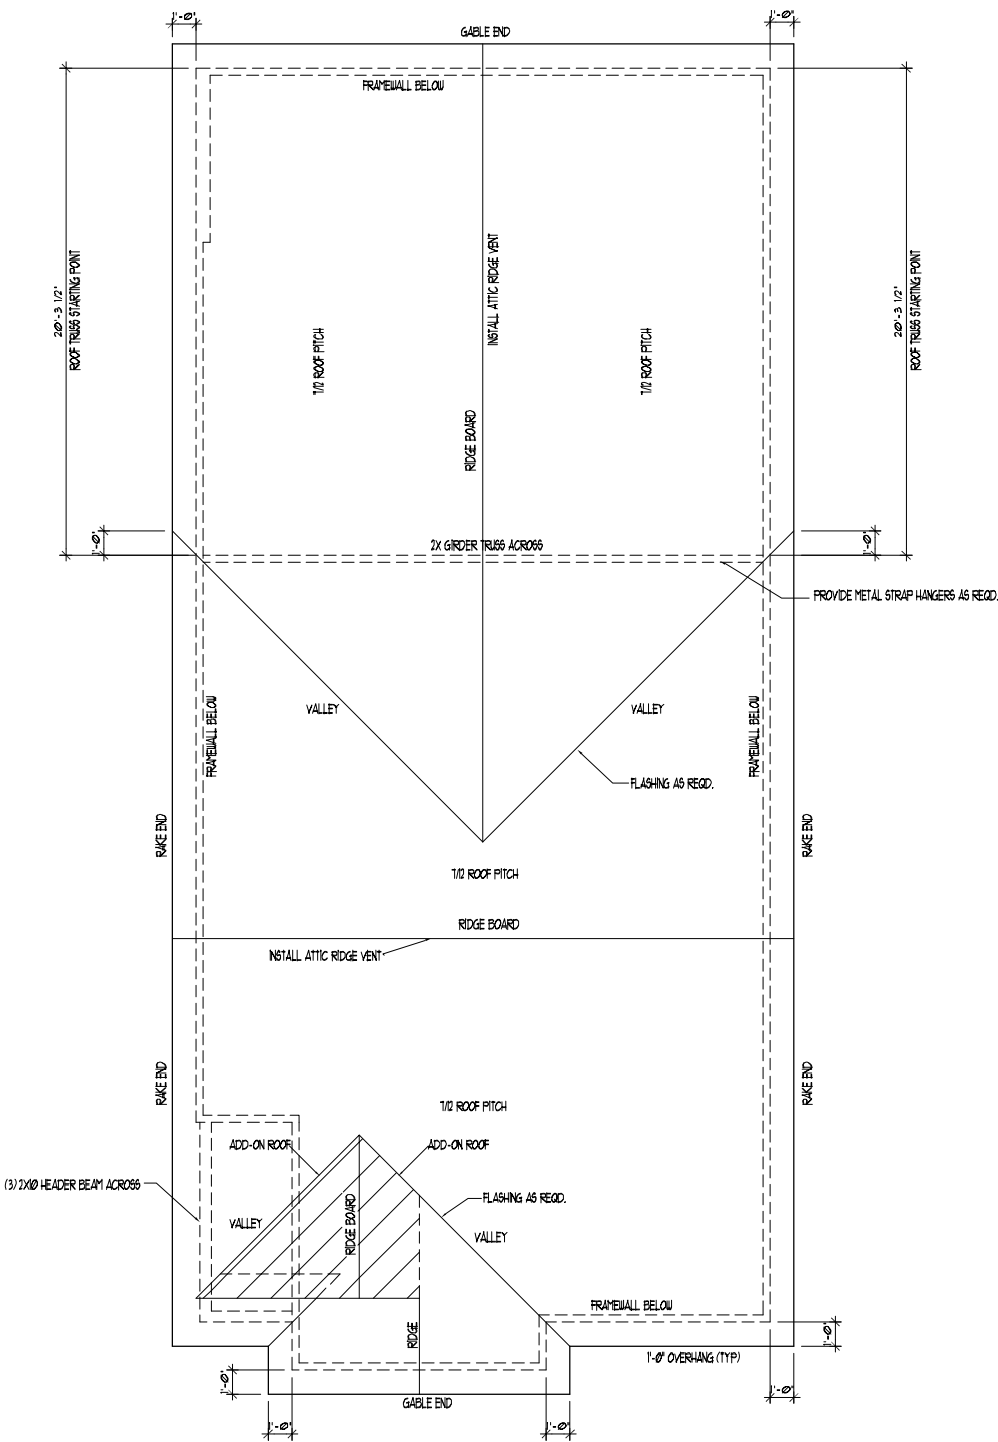


ROOF PLAN LAYOUT

SCALE: 1/8" = 1'-0"

ROOF FRAMING NOTES:

- ALL LADDER RAKE MATERIAL TO BE SUPPLIED BY TRUSS MANUFACTURER
- LADDER RAKE TO BE 2X4 MATERIAL WHEN 1X8 FASCIA IS USED AND 2X6 MATERIAL IS USED
- ALL TRUSSES TO BE SPACED AT 24" O.C. AND DESIGNED BY L.I.C. ENGINEER W/ STAMPED CERTIFICATION BY THE STATE OF INDIANA
- SEE ELEVATIONS FOR ALL ROOF PITCH INFORMATION. (DO NOT SCALE OFF DRAWINGS)

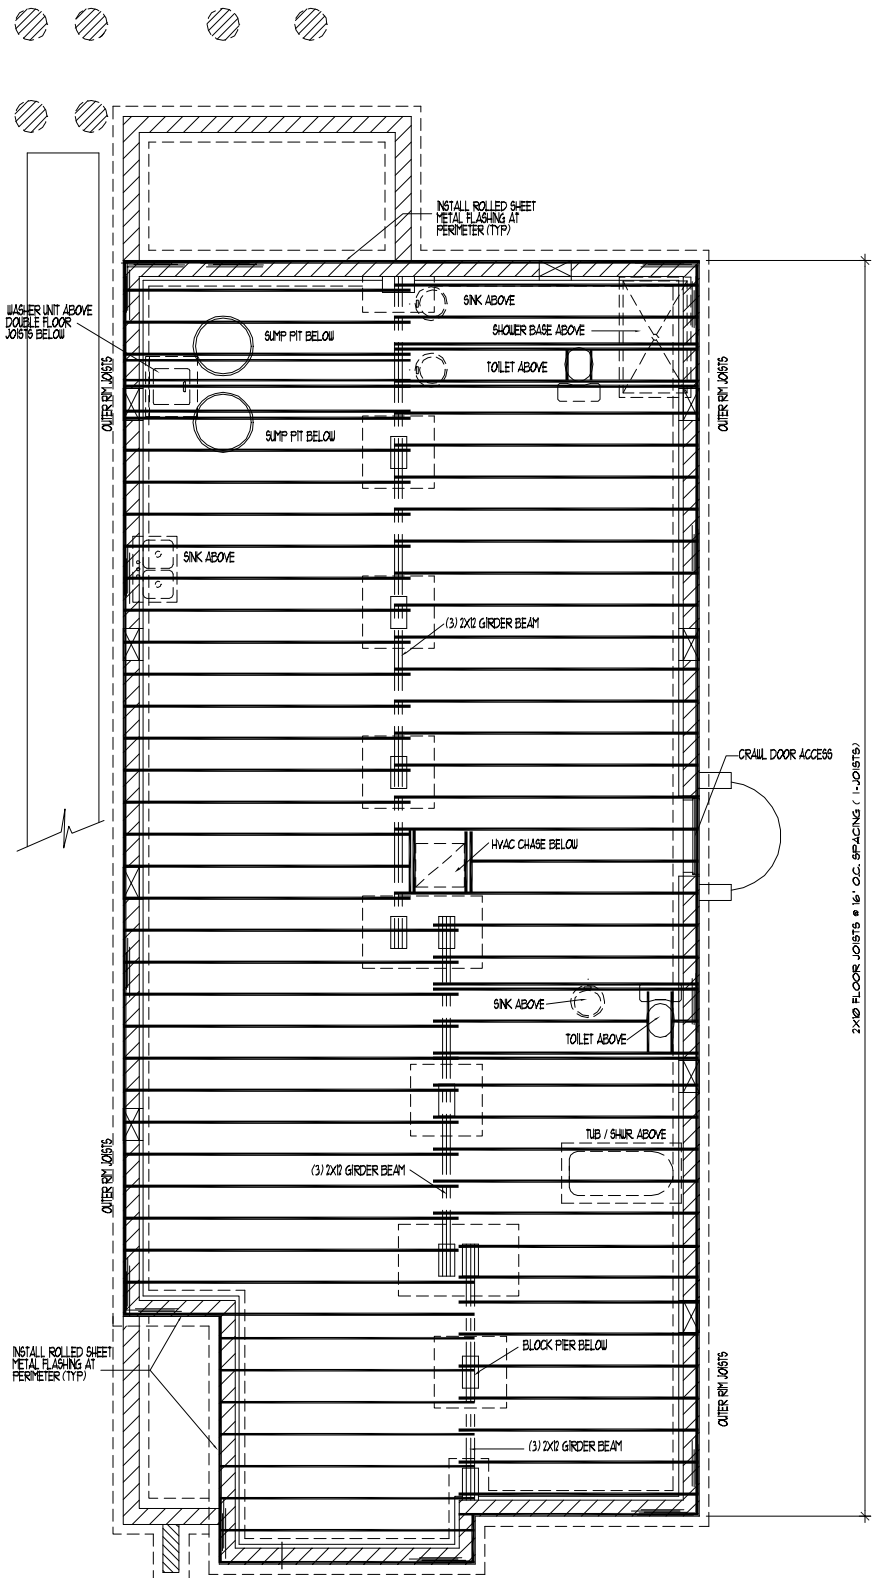


FLOOR FRAMING PLAN

SCALE: 1/8" = 1'-0"



FORTE DESIGN INC		Covington - A		RENEW INDIANAPOLIS	
CLIENT: RENEW INDIANAPOLIS 1704 Bellefontaine St Indianapolis, IN 46202	LIVING S.F. 1237	DRAWN BY M. Forte	SCALE: 1/8"=1'-0"	DATE 6-16-22	WORK SITE: _____ INDIANAPOLIS, INDIANA
				SHT. NO. 5	OF 6

****NOTE****
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MAIN FLOOR PLAN

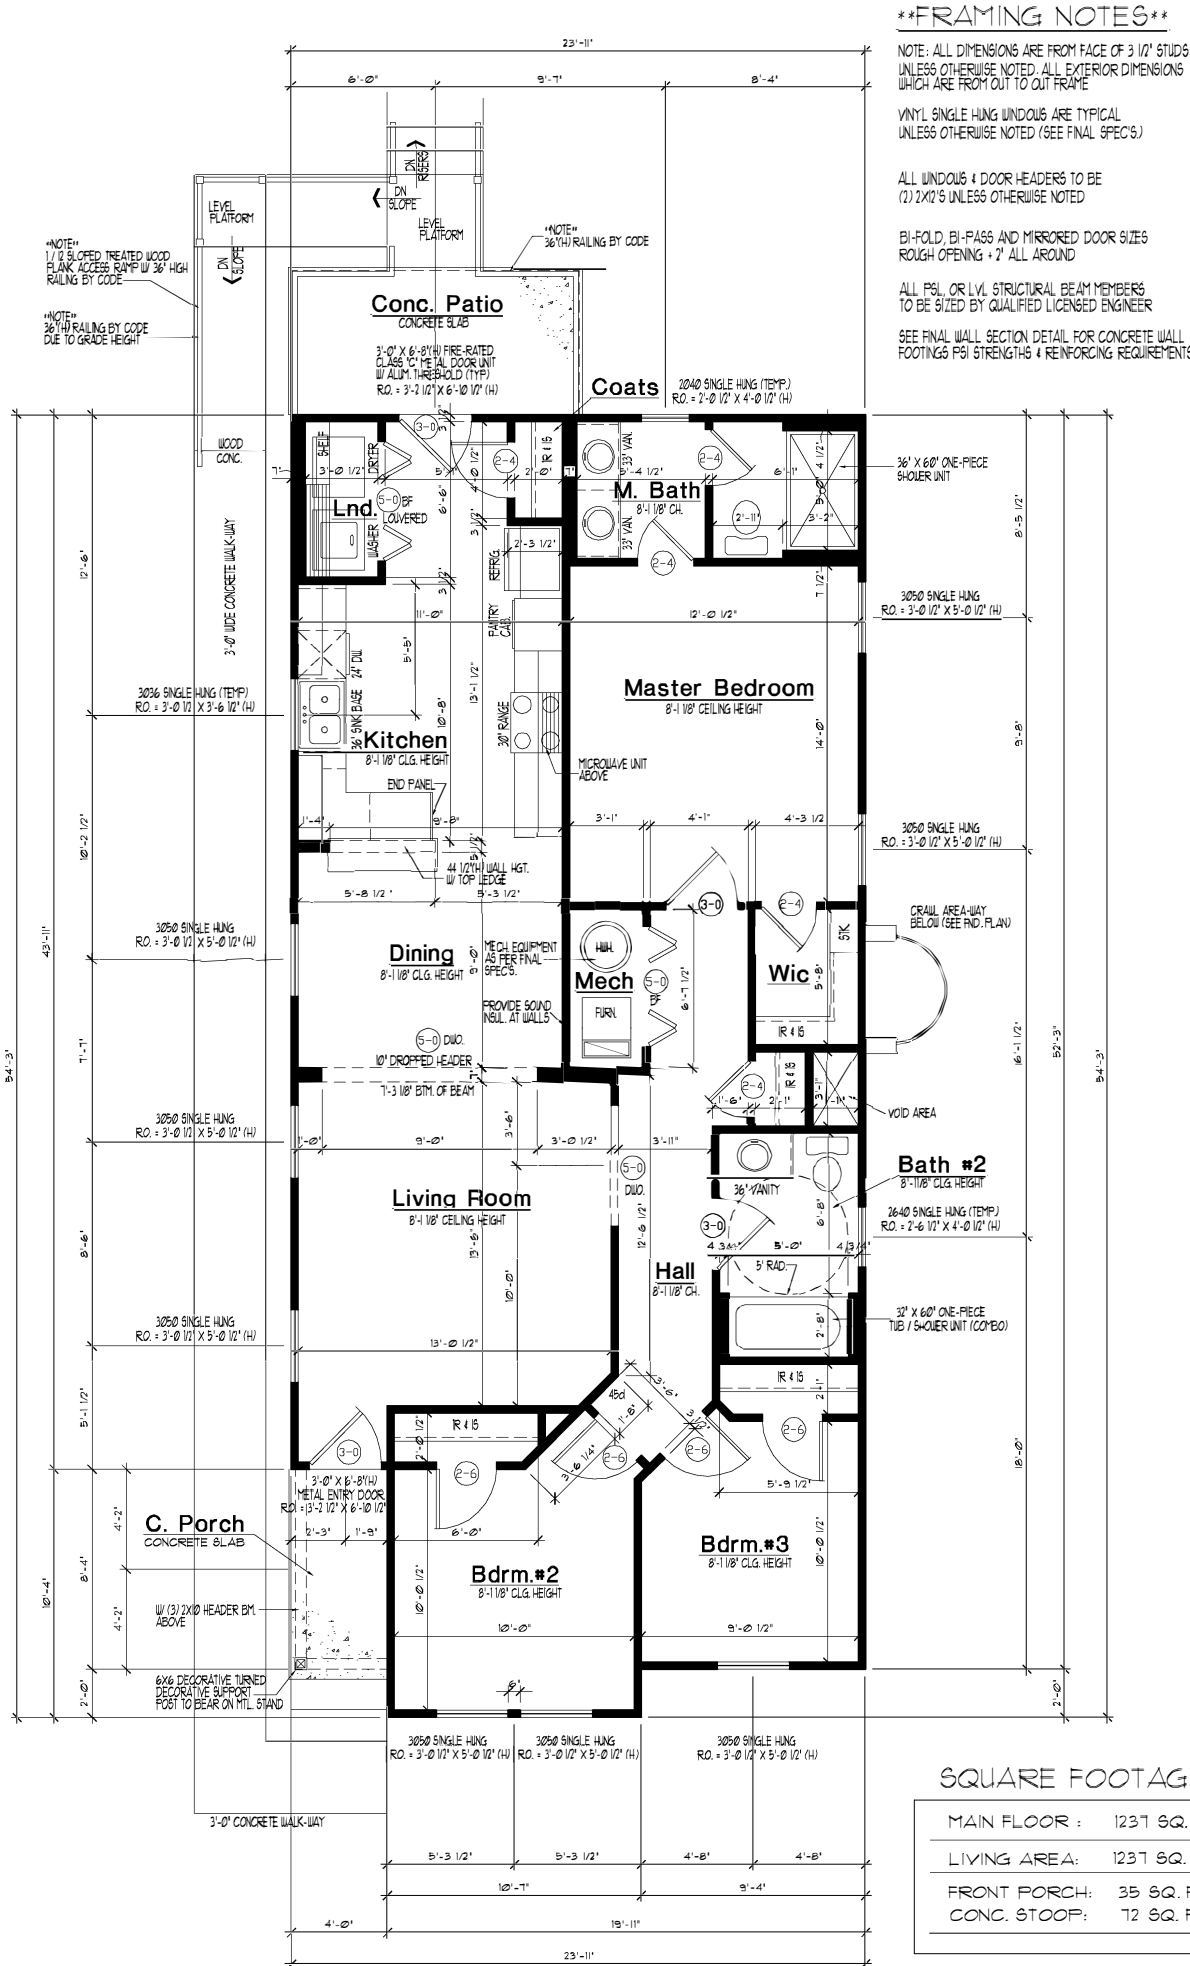SCALE: 1/8" = 1'-0"

ASSUME: 8'-1 1/8" MAIN WALL HEIGHT TYP. (UNLESS OTHERWISE NOTED)
 ASSUME: 6'-8" HEIGHT DOORS & CASSED OPENINGS BOTH INTERIOR & EXTERIOR



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FORTE DESIGN INC		Covington - A		RENEW INDIANAPOLIS	
CLIENT: RENEW INDIANAPOLIS 1704 Bellefontaine St Indianapolis, IN 46202	LIVING S.F. 1237	DRAWN BY M. Forte	SCALE: 1/8"=1'-0"	DATE 6-16-22	WORK SITE: _____ INDIANAPOLIS, INDIANA
				SHT. NO. 4	OF 6